





1 FLOOR PLAN
SCALE 1:75

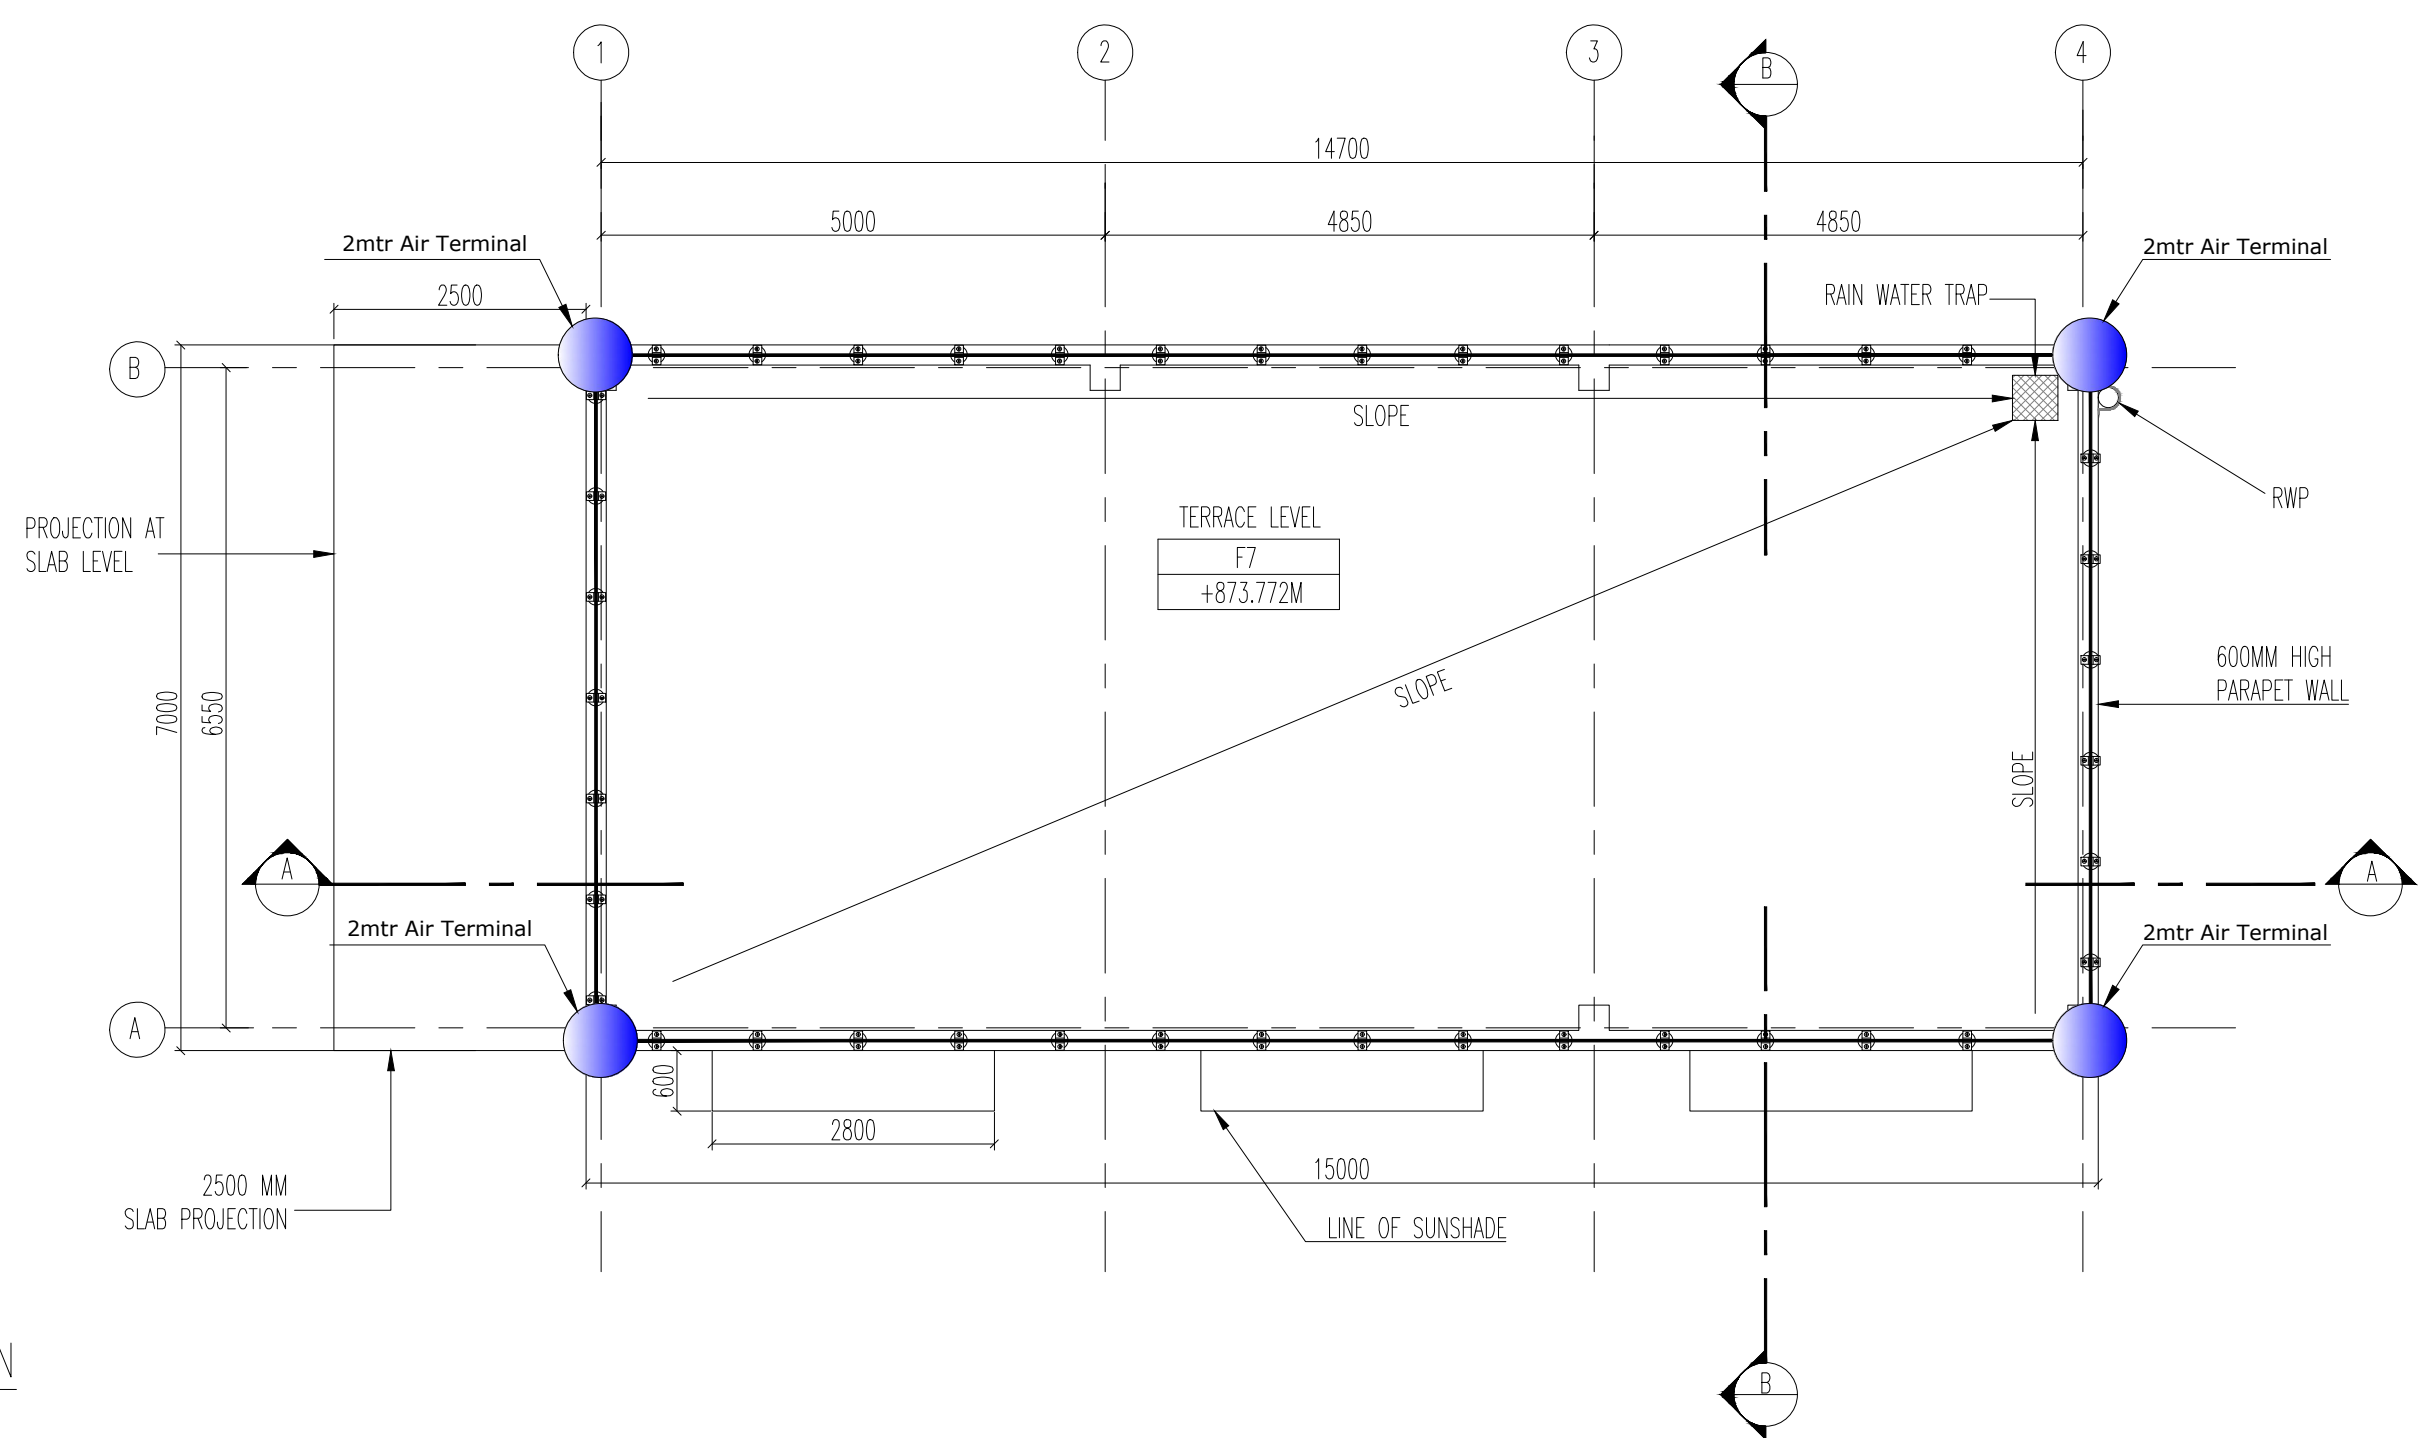


2 TERRACE PLAN
SCALE 1:75


ABBREVIATIONS			
CL	CENTRE LINE		
RWP	RAIN WATER PIPE		
DOOR SCHEDULE			
CODE	DIMENSION	LINTEL	
RS7	2950 X 3000 MM	2400 MM	
FLD1	3000 X 2400 MM	2400 MM	
FD2	1000 X 2400 MM	2400 MM	
WINDOW SCHEDULE			
CODE	DIMENSION	SILL	LINTEL
WN4	1500X1500 MM	900 MM	2400 MM
FLOOR FINISH SCHEDULE			
CODE	DESCRIPTION		
F9	CONCRETE FLOORING		
F7	WEATHERING COURSE		
INTERNAL WALL FINISH SCHEDULE			
CODE	DESCRIPTION		
I1	ACRYLIC EMULSION PAINT		
I5	100 MM HIGH CEMENT SKIRTING		
I9	100 MM HIGH WEATHERING COURSE SKIRTING		
I10	EXTERIOR EMULSION PAINT		
	200 MM THK BLOCKWORK		
	STRUCTURAL WALL AS/STR.Dwg		

- NOTES
- THIS DRAWING IS FOR INFORMATION AND REFERENCE AS A GENERAL GUIDANCE ONLY.
 - ALL DEPOT FACILITIES, PLANTS & MACHINERIES, ACCOMMODATION FACILITIES, SYSTEM WIDE REQUIREMENTS ETC.SHALL BE VERIFIED FOR MAINTENANCE REQUIREMENT OF ROLLING STOCK AND INFRASTRUCTURE FACILITIES.
 - ALL DIMENSIONS ARE IN MM UNLESS NOTED OTHERWISE AND TO BE READONLY NOT MEASURED.
 - ABSOLUTE RAIL LEVEL SHALL BE DERIVED FROM APPROVED ALIGNMENT DRAWINGS.
 - STRUCTURE SYSTEM SHOWN IS INDICATIVE. ALL STRUCTURE MEMBER SIZES TO BE DETAILED BY DESIGNER AT LATER STAGE.
 - THIS DRAWINGS HAVE BEEN DEVELOPED IN CONFORMITY TO DPR,SOD, BSRP& OTHER CODAL REQUIREMENTS.
 - SYSTEM ROOM SIZES, HEIGHTS, DOOR SIZE, FLOOR HEIGHT AND CUTOFF DIMENSIONS TO BE VERIFIED BY RELEVANT DISCIPLINES OF ENGINEERING.
 - SHAFTS FOR ELECTRICAL, SAT, PLUMBING, DRAINAGE, SEWAGE DISPOSAL, RAIN WATER HARVESTING, FIRE AND OTHER SYSTEMS SHALL BE PROVIDED AS PER SYSTEM AND MEP REQUIREMENTS.
 - ALL FINISHES ARE SUBJECT TO K-RIDE APPROVAL.
 - SIZE, SPACING AND ARRANGEMENTS OF THE BRUSH SUPPORT SYSTEM WILL BE PROVIDED BY THE VENDOR
 - ALL ITEMS ARE AS PER BOQ.
 - LEVELS SHOWN ARE INDICATIVE FINAL LEVELS SHOULD BE CONFIRMED BEFORE EXECUTION OF THE WORK.
 - M&P INPUTS ARE MARKED TENTATIVELY

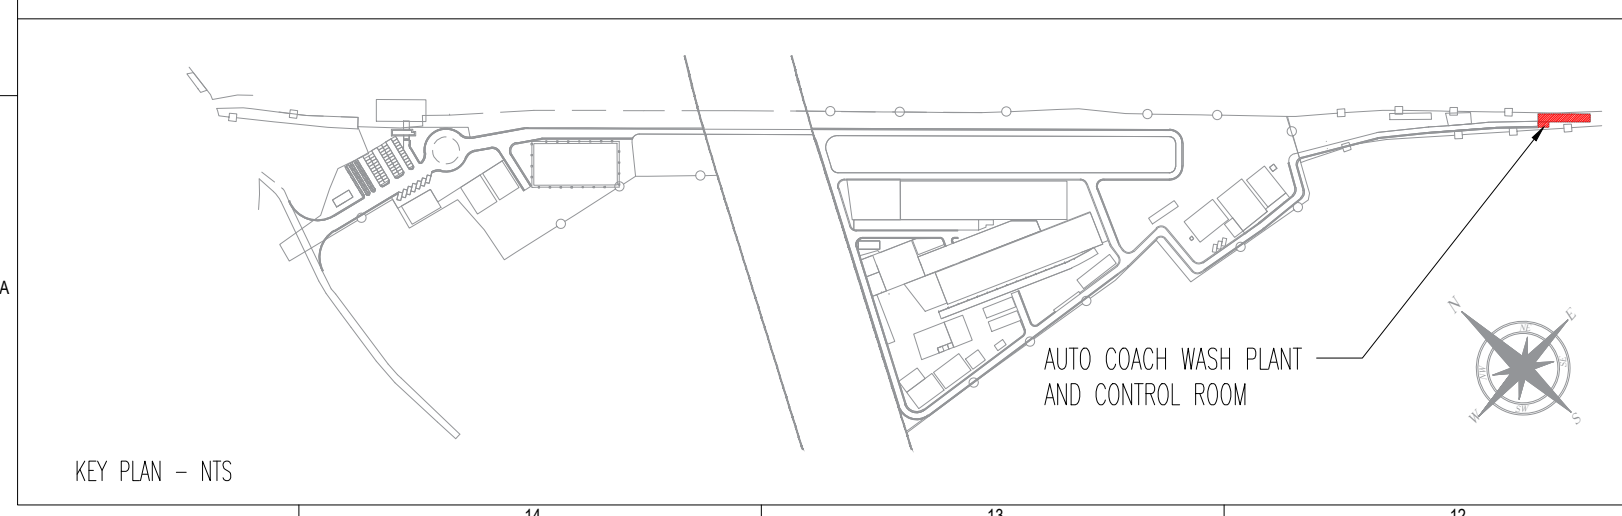

KEY PLAN - NTS

REVISIONS			DDC CONSULTANT	PROOF CONSULTANT (PC):	DETAILED DESIGN CONSULTANT DDC						GENERAL CONSULTANT(AECOM-EGIS-WSP)					KRIDE				PROJECT :												
					PREPARED , CHECKED AND APPROVED						CHECKED AND APPROVED				COUNTER SIGN	CHECKED AND APPROVED				BENGALURU SUBURBAN RAILWAY PROJECT (BSRP)												
																					KRIDE SOLADEVANAHALLI DEPOT											
																					DRAWING TITLE : AUTO COACH WASH PLANT AND CONTROL ROOM GROUND FLOOR PLAN AND TERRACE PLAN											
																					DRAWING NO : SDH-DP-ACW-01-ARC-PD-001											
																					SCALE = 1:75		SHEET NO.		DATE		REVISION		DWG STATUS			
																					AS SHOWN		1 OF 2		07.06.2025		R5		PD			
																					PRELIMINARY DWG(PD),DEFINITIVE DWG(DD),CONSTRUCTION DWG(CD)					SHEET SIZE						
																					AS BUILT DWG(BD), SHOP DWG(SD), MANUFACTURED DWG(MD)					A1						
REV.NO.	DATE	DESCRIPTION																														
R5	07.06.2025	REVISED AS PER GC COMMENTS		BALAJI RAILROAD	SYSTEMS (P) LIMITED																											
R4	19.05.2025	REVISED AS PER GC COMMENTS																														
R3	15.04.2025	REVISED AS PER GC COMMENTS																														
R2	25.03.2025	REVISED AS PER GC COMMENTS																														
R1	21.03.2025	REVISED AS PER GC COMMENTS																														
R0	03.02.2025	FLOOR PLAN																														

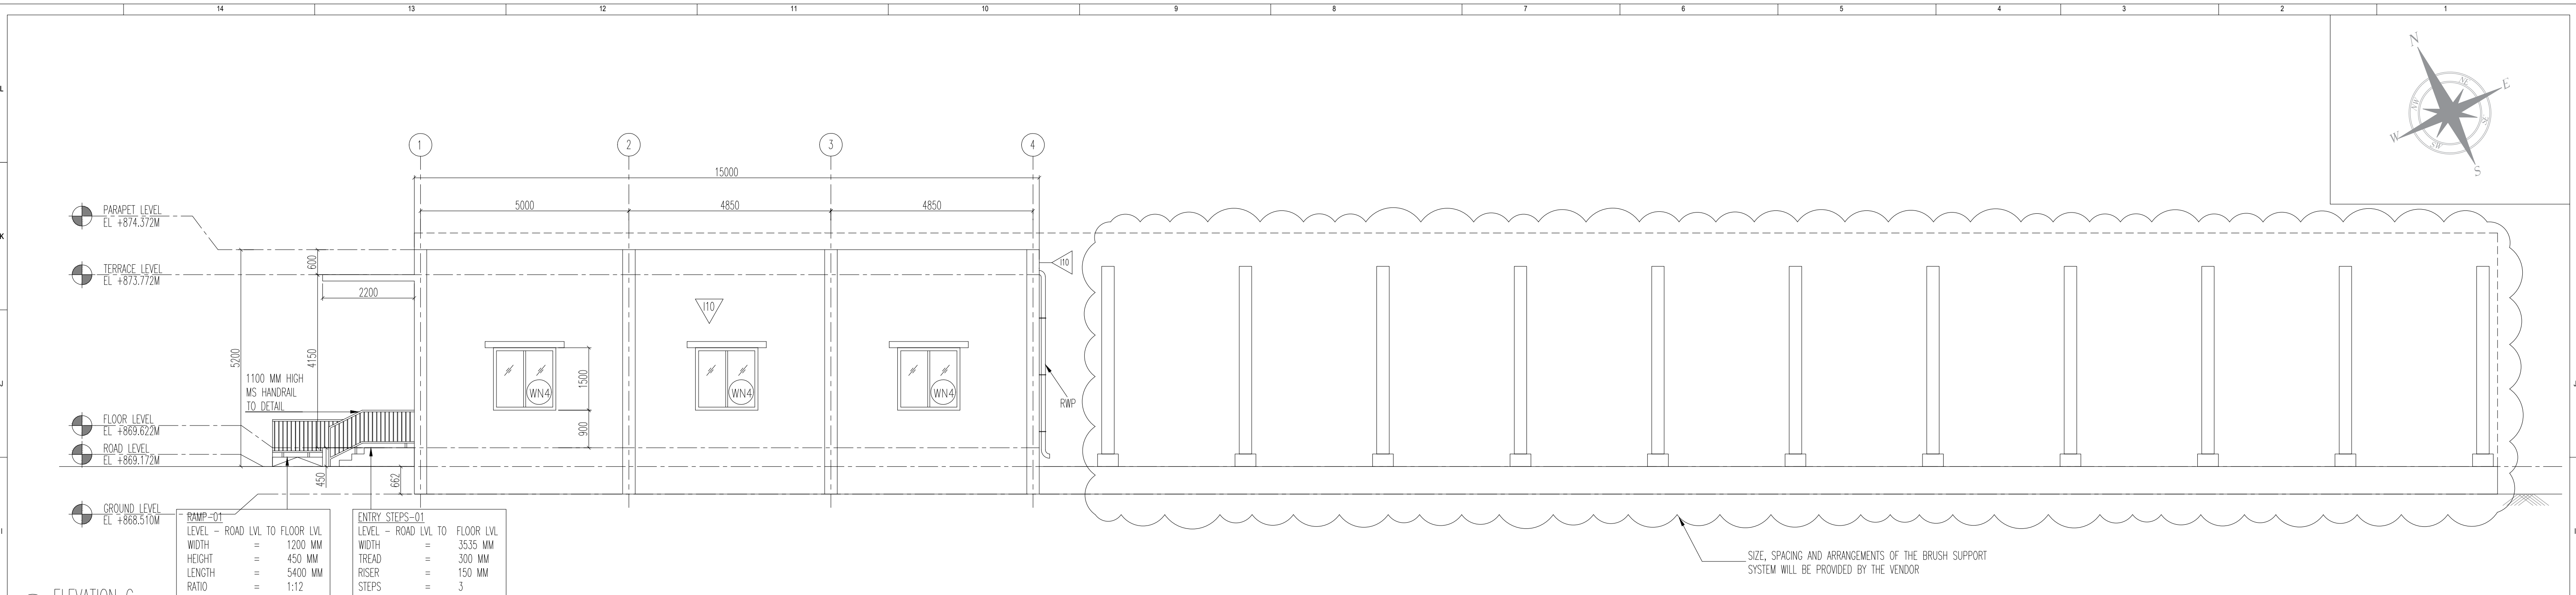

ELEVATION C
SCALE 1:75

1 2 3 4

15000

4850 4850

600MM HIGH PARAPET WALL

2200 MM SLAB PROJECTION

100MM THK WEATHERING COURSE

PARAPET WALL

RCC BEAM

RCC COLUMN SEEN IN ELEVATION

ROLLING SHUTTER DRUM

1100 MM HIGH MS HANDRAIL TO DETAIL

CONTROL ROOM

RS7

FLD1

15

F9

WN4

11

10

RWP

REFER STRUCTURAL DWG FOR DETAILS

REFER STRUCTURAL DWG FOR DETAILS

SIZE, SPACING AND ARRANGEMENTS OF THE BRUSH SUPPORT SYSTEM WILL BE PROVIDED BY THE VENDOR

PARAPET LEVEL
EL. +874.372M

TERRACE LEVEL
EL. +873.772M

FLOOR LEVEL
EL. +869.622M

ROAD LEVEL
EL. +869.172M

GROUND LEVEL
EL. +868.510M

5200

4150

2200

1000

3000

4000

1500

900

662

450

RAMP-01	
LEVEL - ROAD LVL TO FLOOR LVL	
WIDTH	1200 MM
HEIGHT	450 MM
LENGTH	5400 MM
RATIO	1:12

ENTRY STEPS-01	
LEVEL - ROAD LVL TO FLOOR LVL	
WIDTH	3535 MM
TREAD	300 MM
RISER	150 MM
STEPS	3

ABBREVIATIONS	
CL	CENTRE LINE

NOTES

1. THIS DRAWING IS FOR INFORMATION AND REFERENCE AS A GENERAL GUIDANCE ONLY.

2. ALL DEPOT FACILITIES, PLANTS & MACHINERIES, ACCOMMODATION FACILITIES, SYSTEM WIDE

SECTION BB
SCALE 1:75

CODE	DIMENSION	UNIT
RS7	2950 X 3000 MM	2400 MM
FD1	3000 X 2400 MM	2400 MM
FD2	1000 X 2400 MM	2400 MM

WINDOW SCHEDULE			
CODE	DIMENSION	SILL	LINTEL
WN4	1500X1500 MM	900 MM	2400 MM

FLOOR FINISH SCHEDULE	
CODE	DESCRIPTION
F9	CONCRETE FLOORING
F7	WEATHERING COURSE

INTERNAL WALL FINISH SCHEDULE	
CODE	DESCRIPTION
I10	EXTERIOR EMULSION PAINT
I1	ACRYLIC EMULSION PAINT
I5	100 MM HIGH CEMENT SKIRTING
I9	100 MM HIGH WEATHERING COURSE SKIRTING

APPROVAL STATUS:	EMPLOYER :		
	NONO	NONOC	NOR
			RAIL INFRASTRUCTURE DEVELOPMENT COMPANY(KARNATAKA) LIMITED

[illegible]